




NORTH ELEVATION
SCALE : 1:200

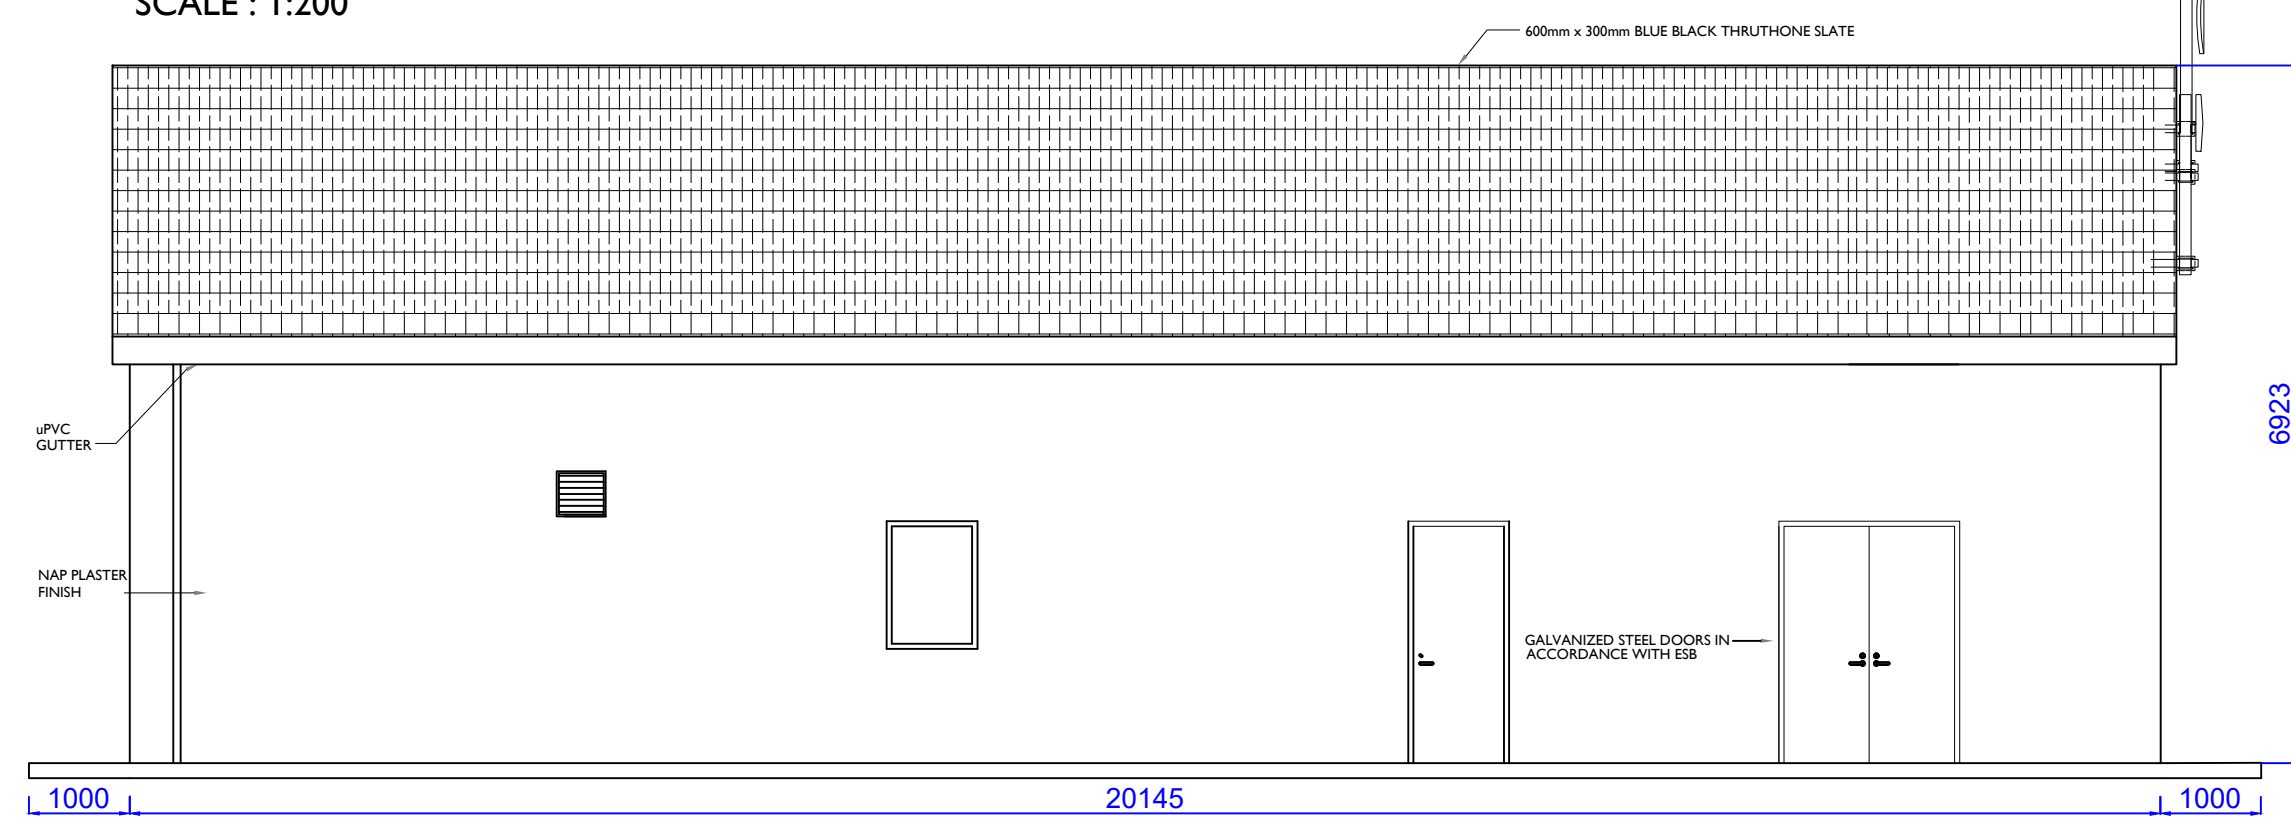


SOUTH ELEVATION
SCALE : 1:200

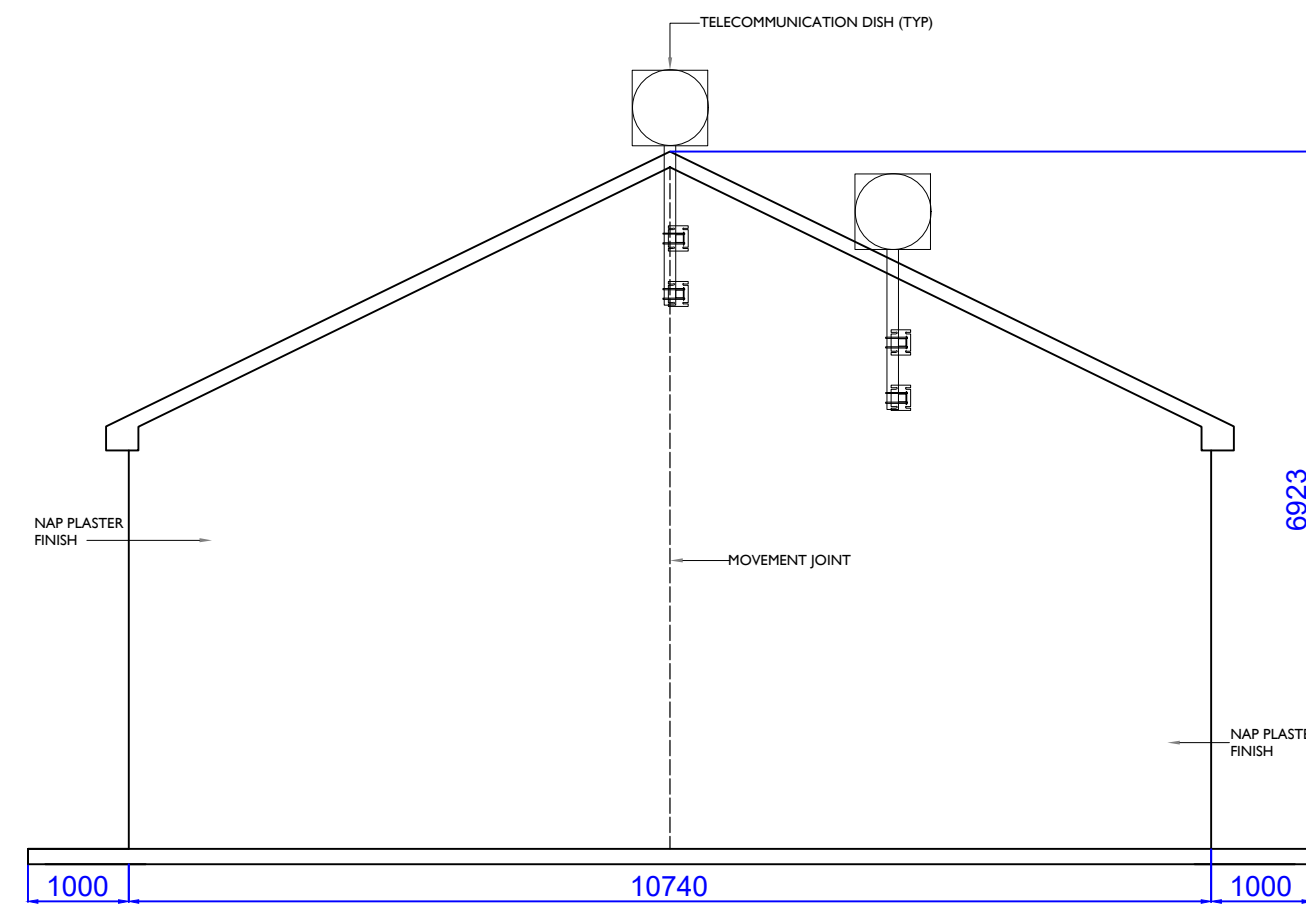

WEST ELEVATION
SCALE : 1:200

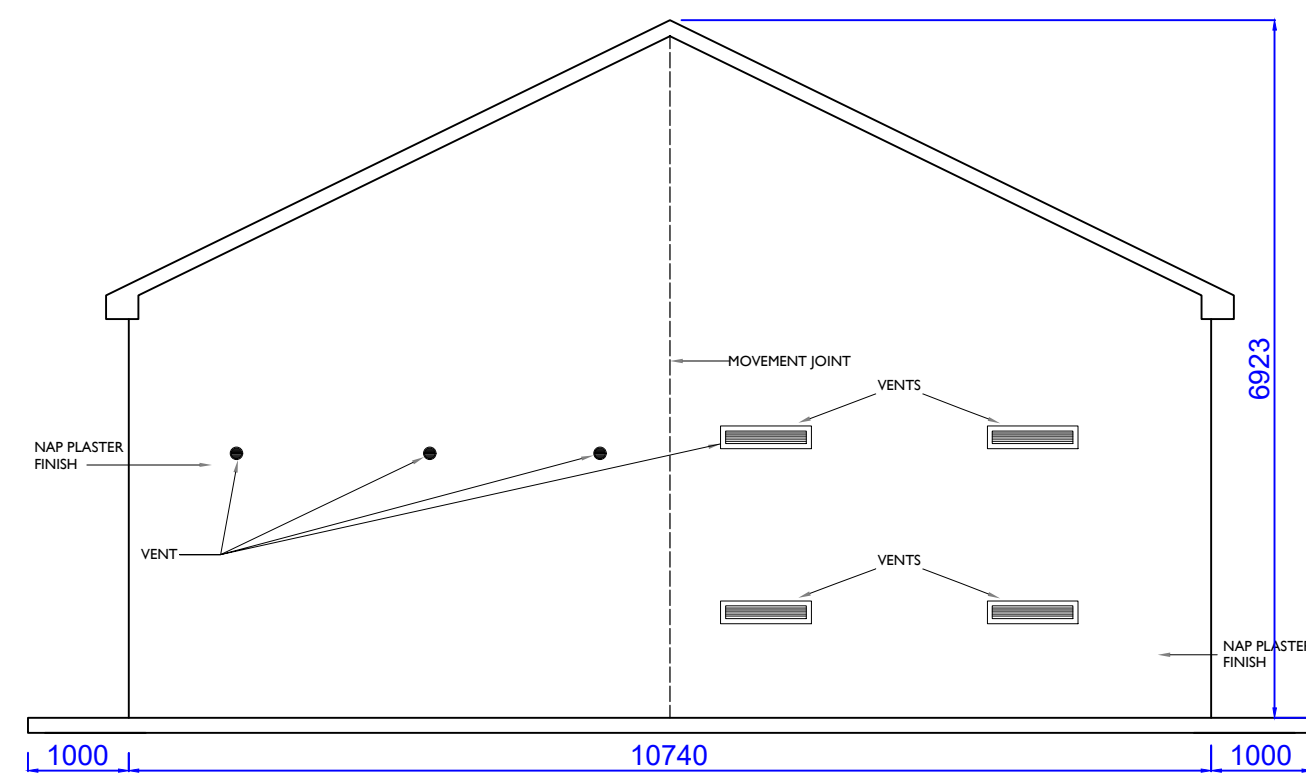

EAST ELEVATION
SCALE : 1:200

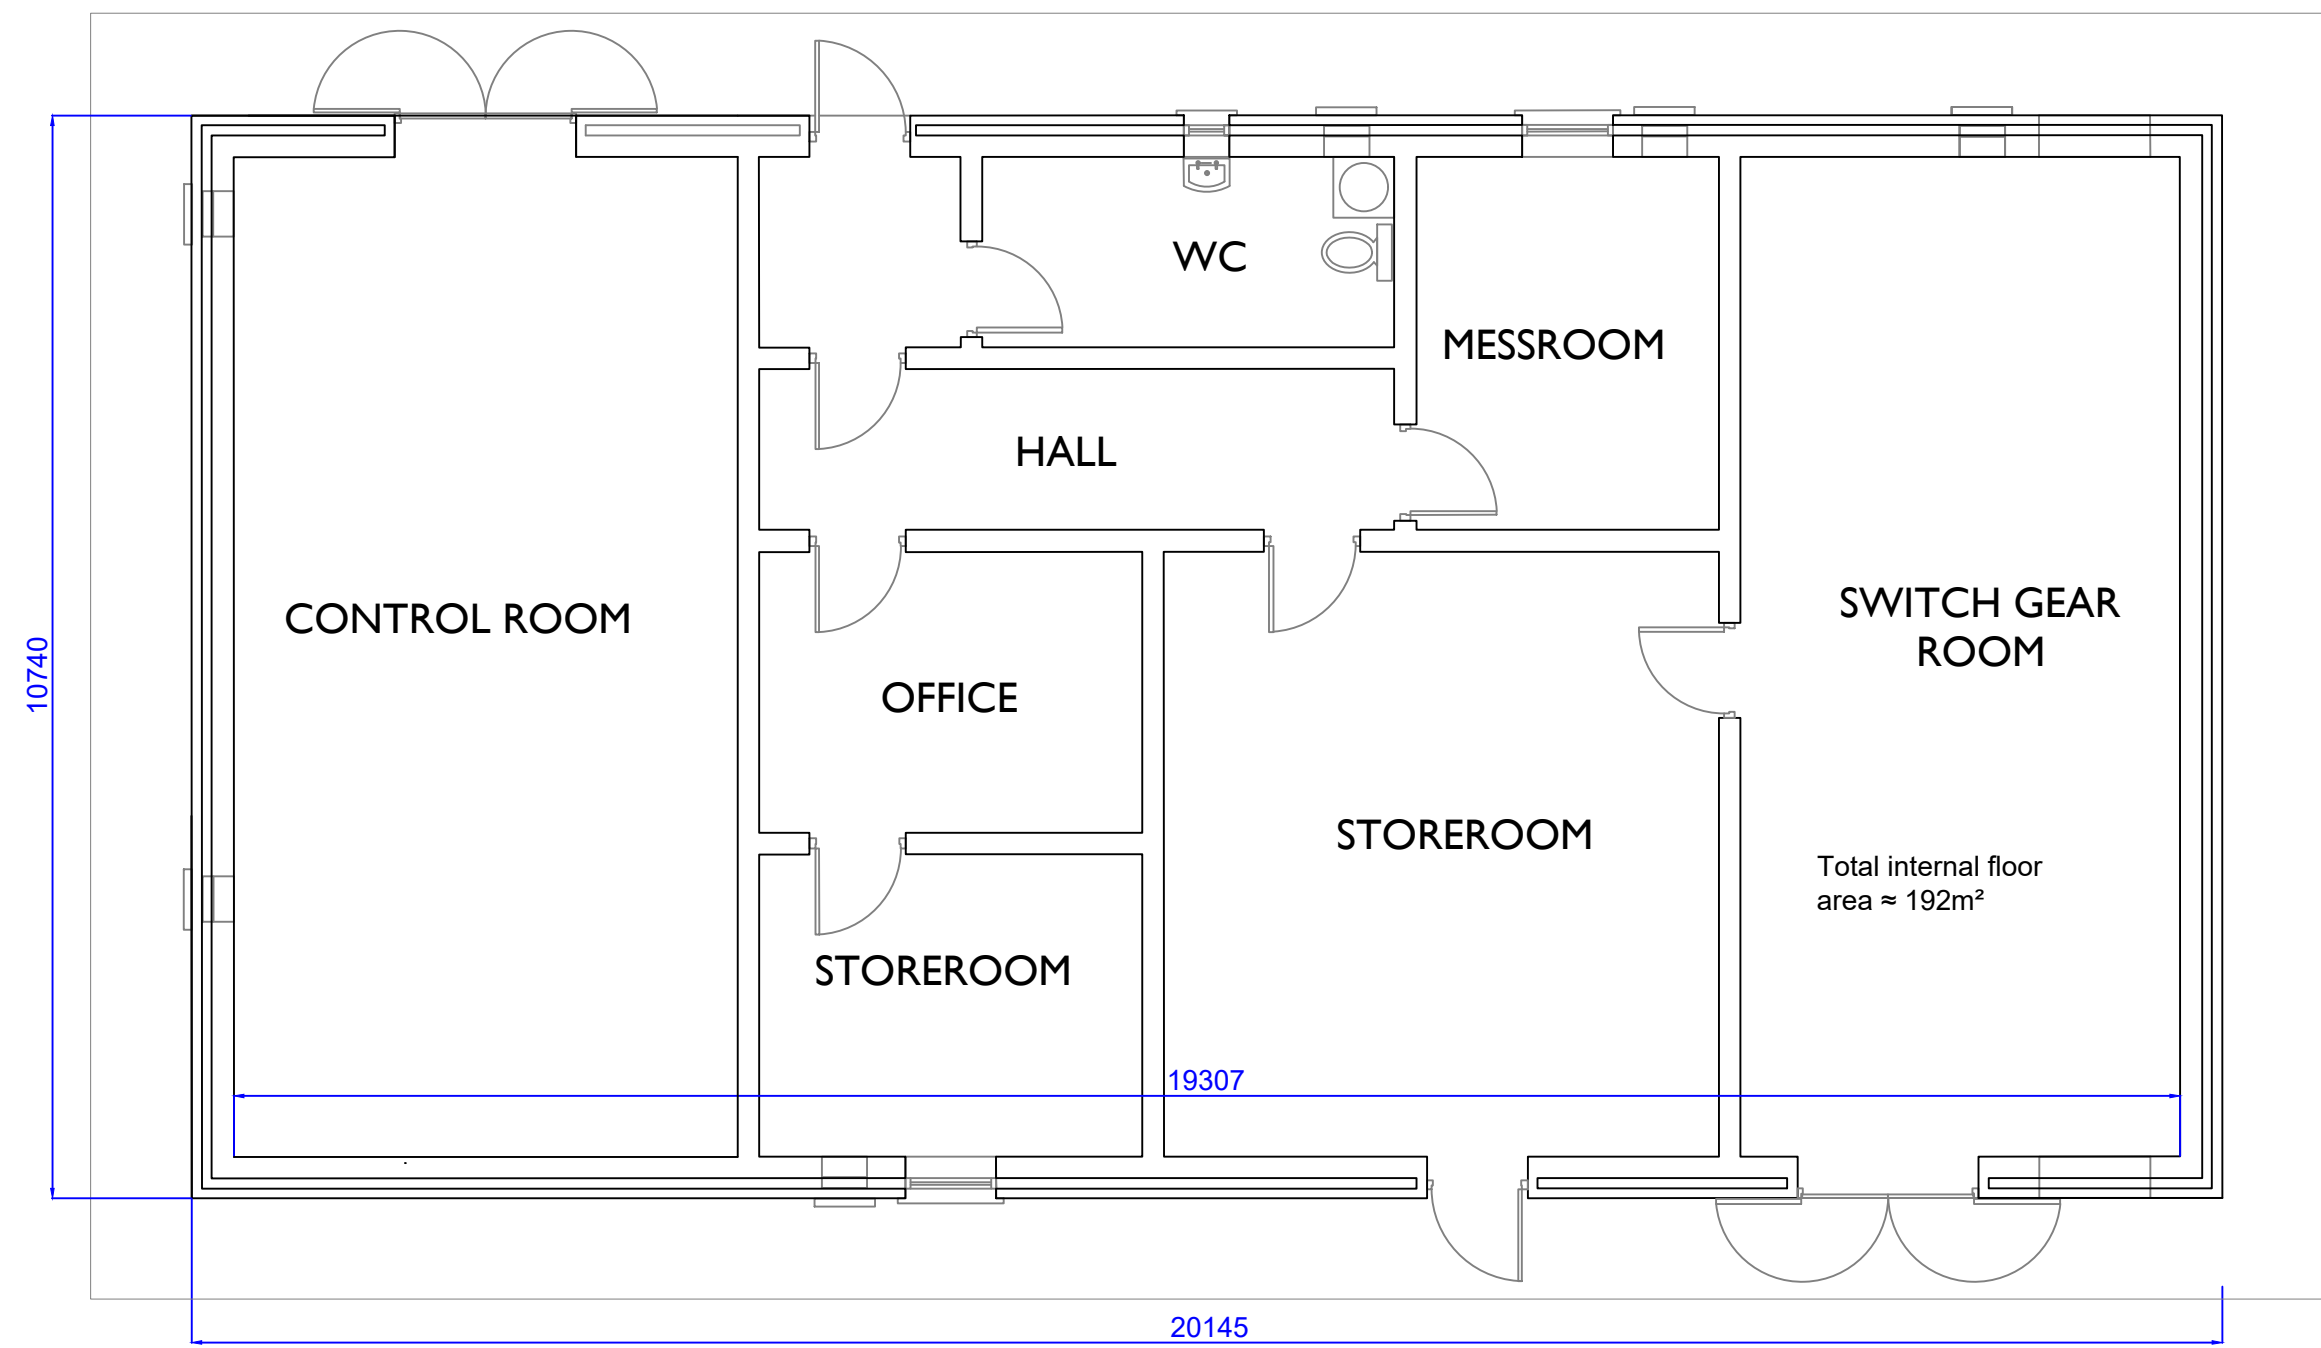

PLAN VIEW
SCALE : 1:200

PROJECT

**Castlebanny Wind Farm
110kV Grid Connection**

CLIENT



CONSULTANTS



NOTES: -

1. Layout and Arrangements of Substation Building and Electrical Equipment is shown indicatively and for illustration purposes only.
2. Dimensions shown are as per current Eirgrid Specifications at the time of submission. Dimensions may vary at time of construction to reflect any revisions to Eirgrid.
3. Final Specifications of Buildings and Electrical Equipment is to be as per Eirgrid and ESB Specifications.
4. The Elevation of the Compound will be depicted by localized Topography such that Cut/Fill Earthworks associated with the construction of the Compound are balanced.

LEGEND: -

ISSUE/REVISION

I/R	DATE	DESCRIPTION
P01	02.12.20	Issued For Planning
P00	04.09.20	Issued for Information

PROJECT NUMBER

05-699

SHEET TITLE

MV Customer Switchgear Room
Plan and Elevations

SHEET NUMBER

05764-DR-205